

Date: 29 September 2022

To: All Plan Holders

Subject: ADDENDUM NO. 2

Project: TROY UNIVERSITY HWY 231 ENTRY SIGN

Job #: SSL# 22016

TROY BID# 22-038

From: Cody Smith

The Plans and Specifications dated September 2022 of the subject project, and any subsequent addenda are amended as follows: (Where there are conflicts between the plans and specifications and the addendum, this addendum shall govern)

Item 1: Refer to the Specification Section 05 5000 Metal Fabrications:

Paragraph 2.01., add the following:

J. Gates, and all associated structure and hardware, shall withstand winds up to 120 miles per hour minimum per all area code requirements.

Paragraph 2.03.F: replace with following:

Hinges for Substation Screen Wall-Provide heavy duty Ball Bearing hinges with integral grease fittings for each Gate. Hinge quantity as required (3 hinges minimum per gate leaf) for a Ten year warranty.

Item 2: Refer to Drawing A1.1 and replace with attached. Added Drop Rod to Gate Elevation.

Item 3: Refer to Drawing A4.1 and replace with attached. Updated Troy University lettering and arrow.


Item 4: Refer to Drawing A5.2 and replace with attached. Clarified Wayfinding Sign Banner.

Item 5: Refer to Specification Section 31 6615 Helical Foundation Piles, Paragraph 2.11. Cantsink will be considered an approved equal subject to requirements of the drawings and specifications

Item 6: Refer to Structural Drawing S3.1 and replace with attached. Added Gate Column Detail 8.

Item 7: Refer to Electrical Drawing E1.0 and replace with attached. Removed Screenwall floodlights.

End of Addendum No. 2

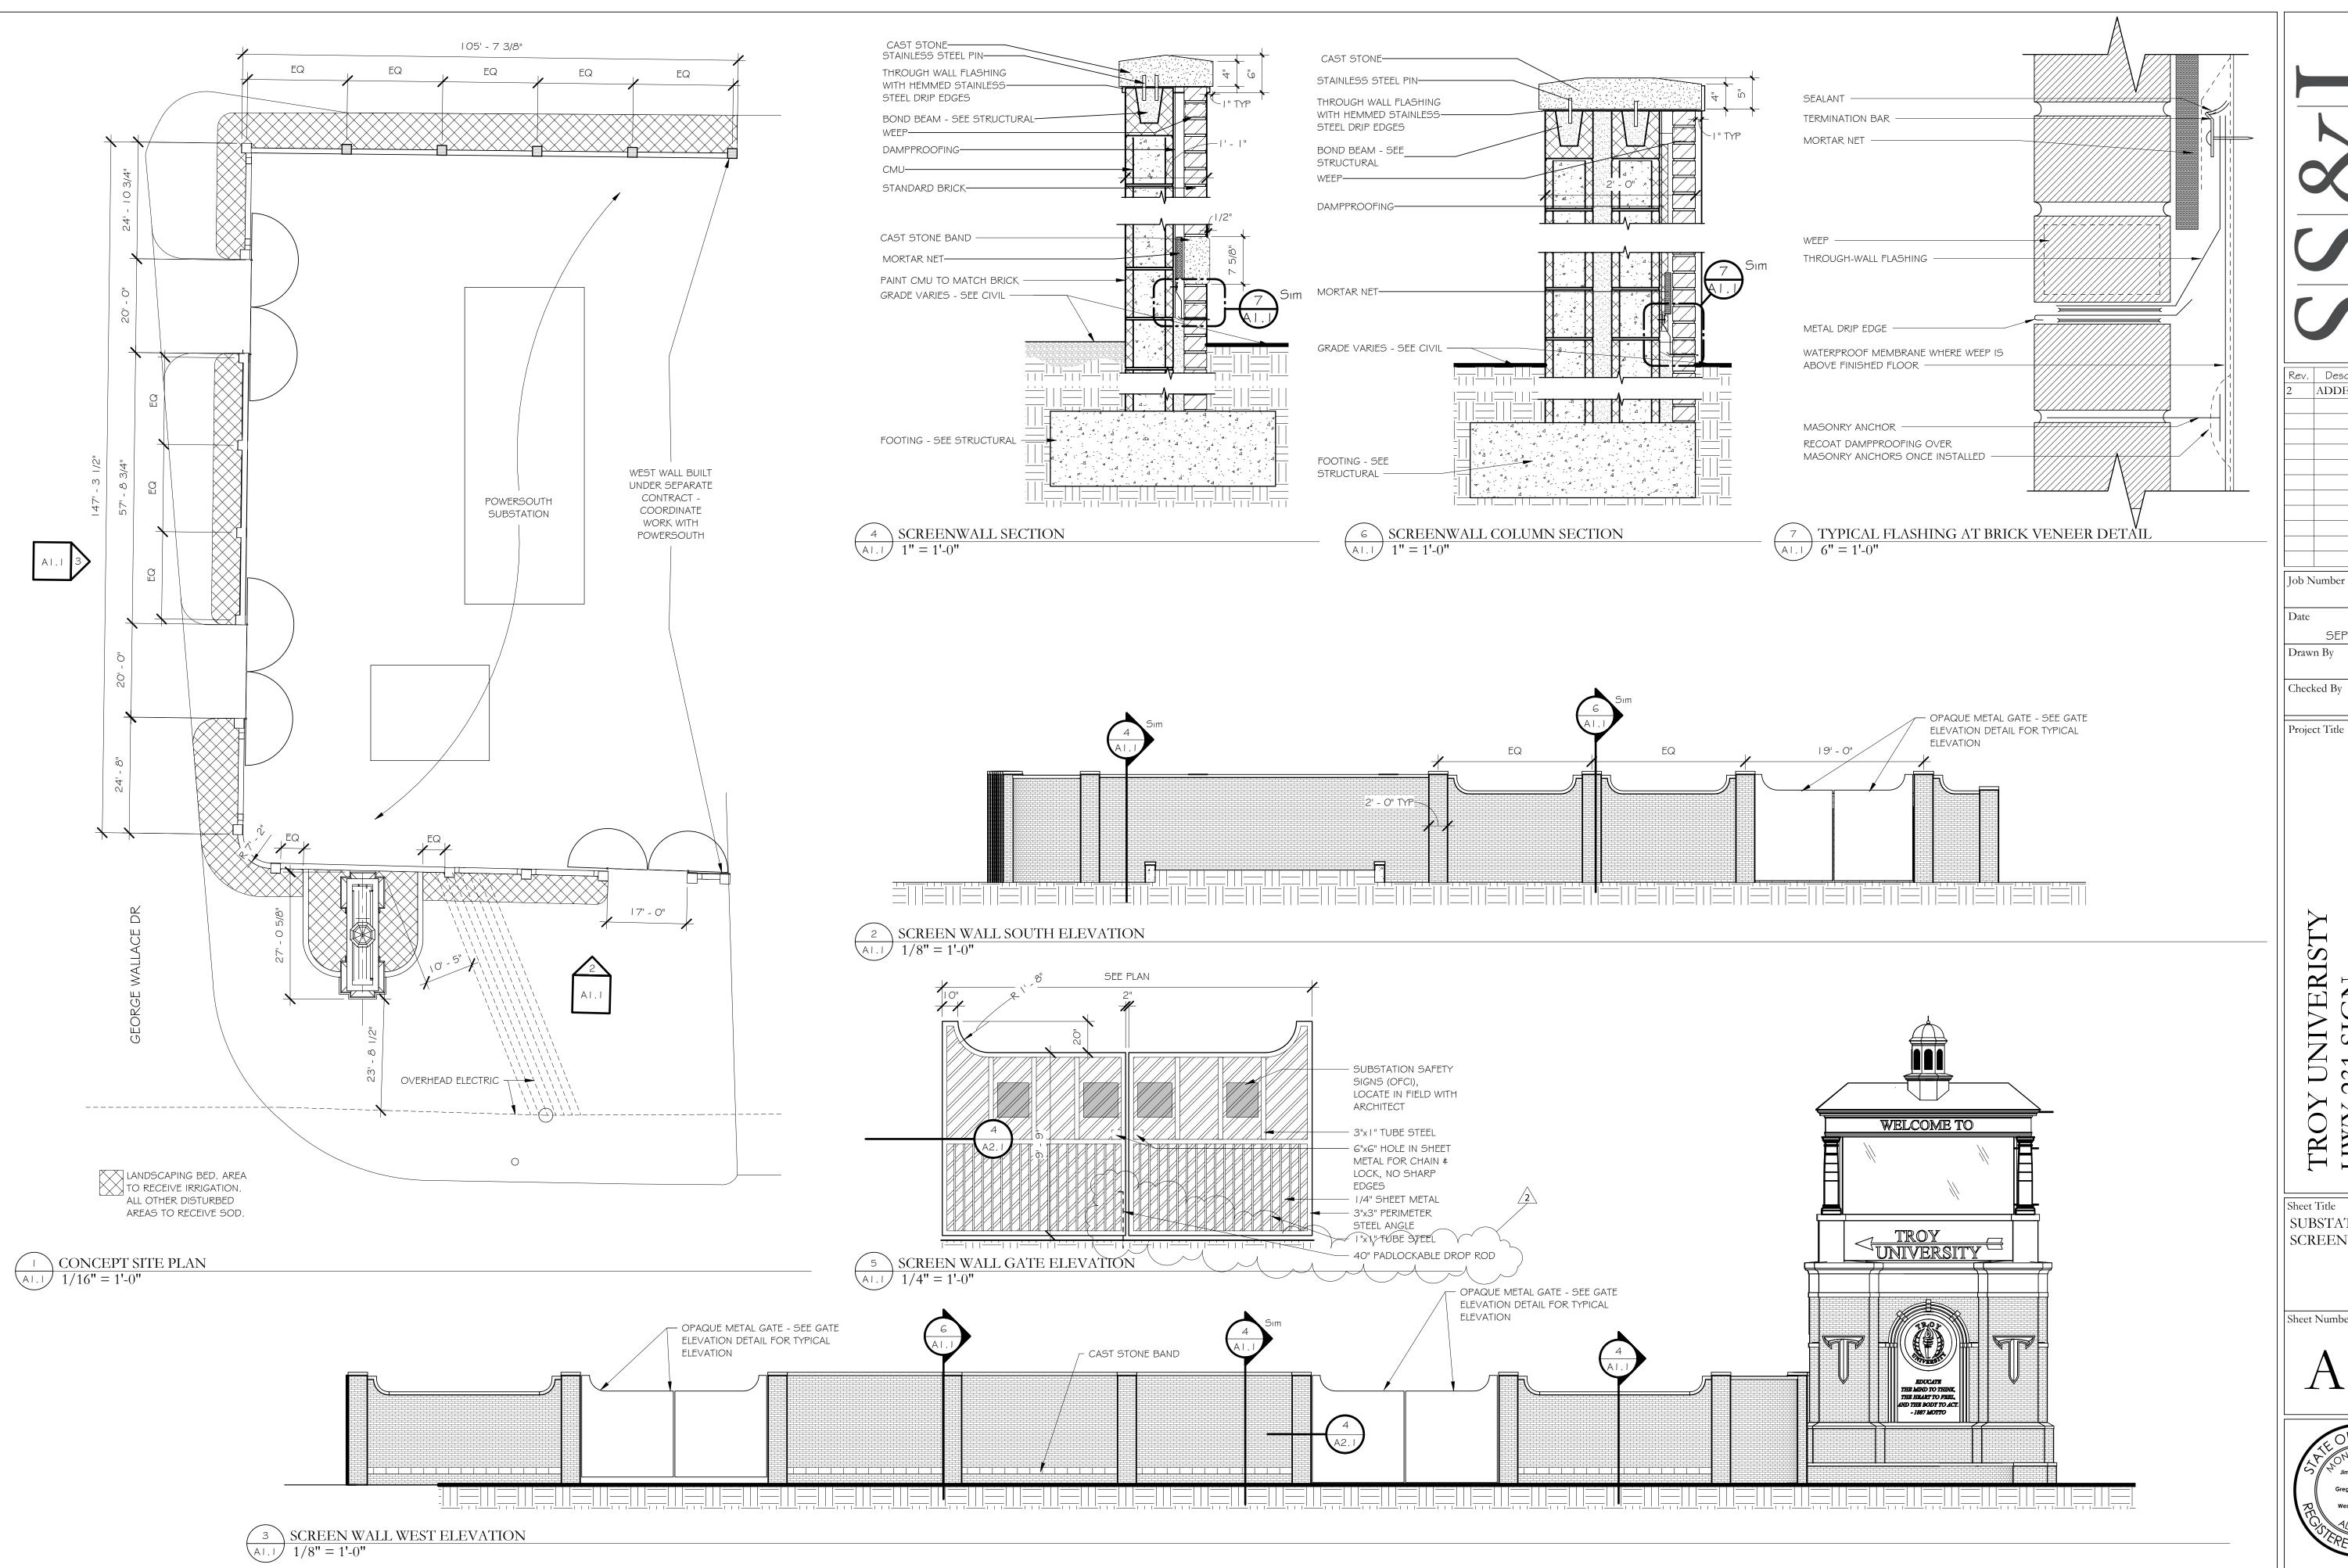


Rev. Description Date ADDENDA 2 | 09.26.22 Job Number


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Sheet Title SUBSTATION SCREENWALL






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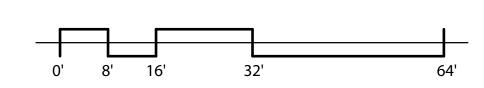
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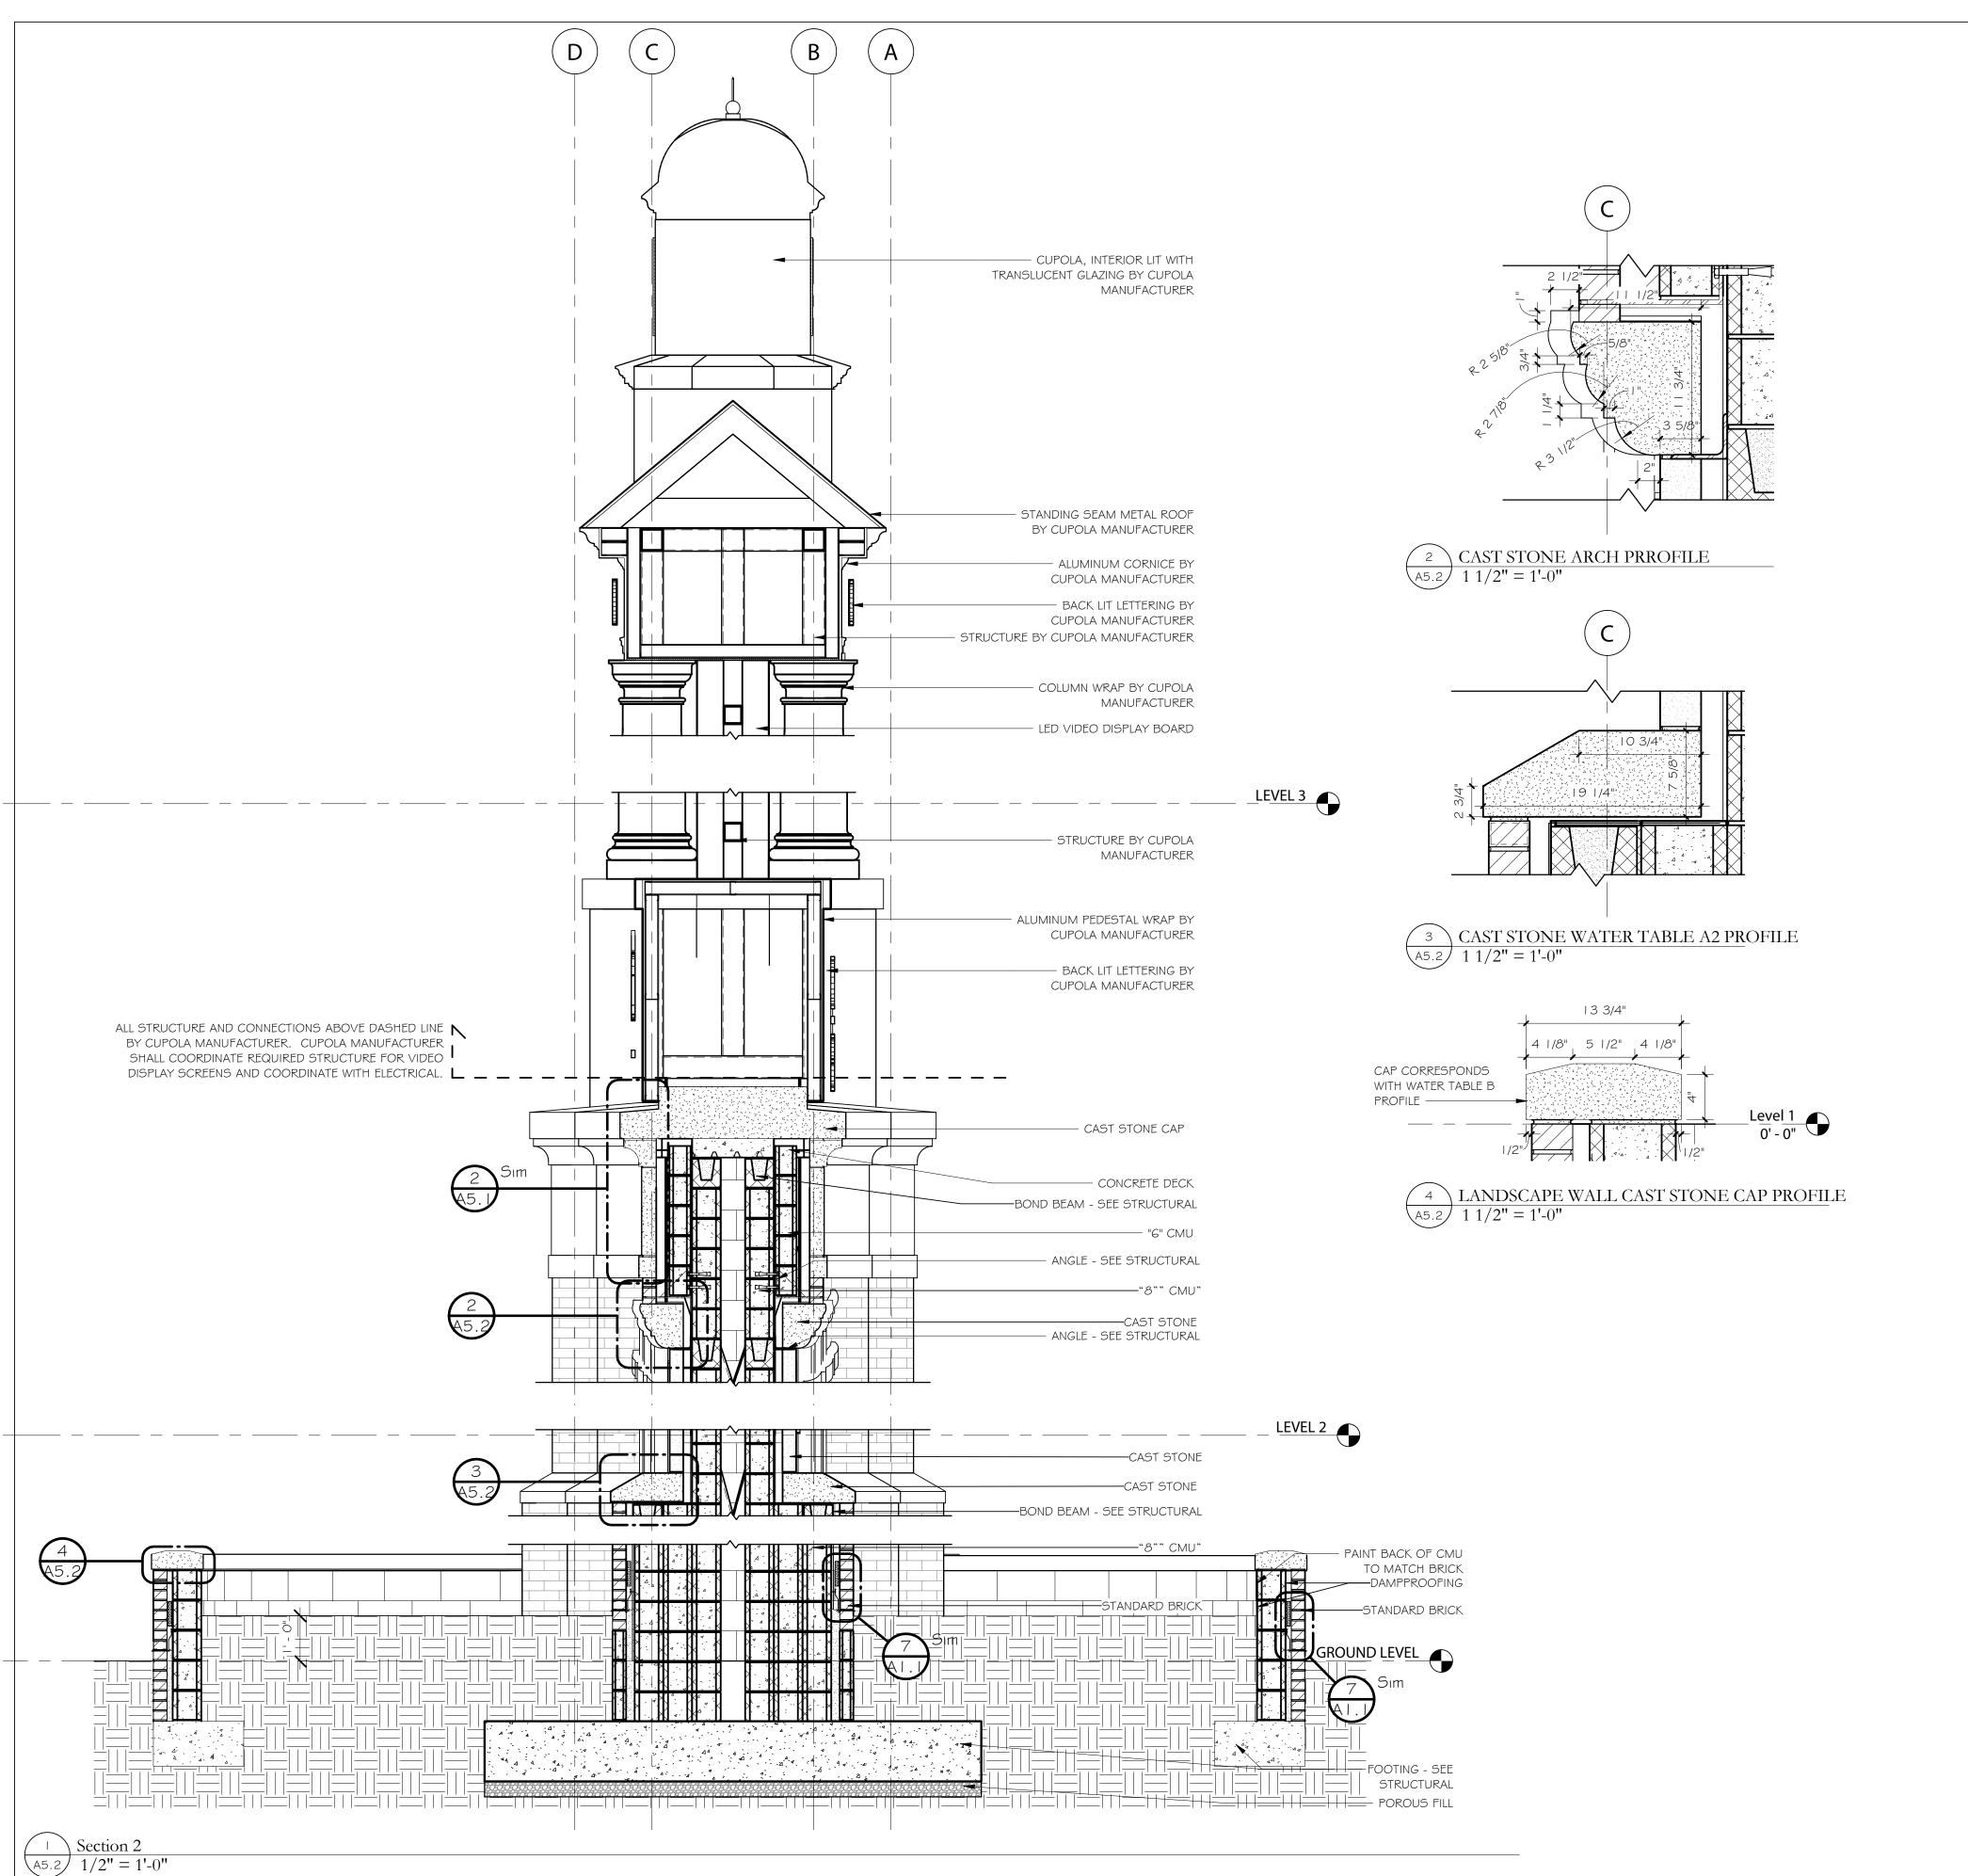
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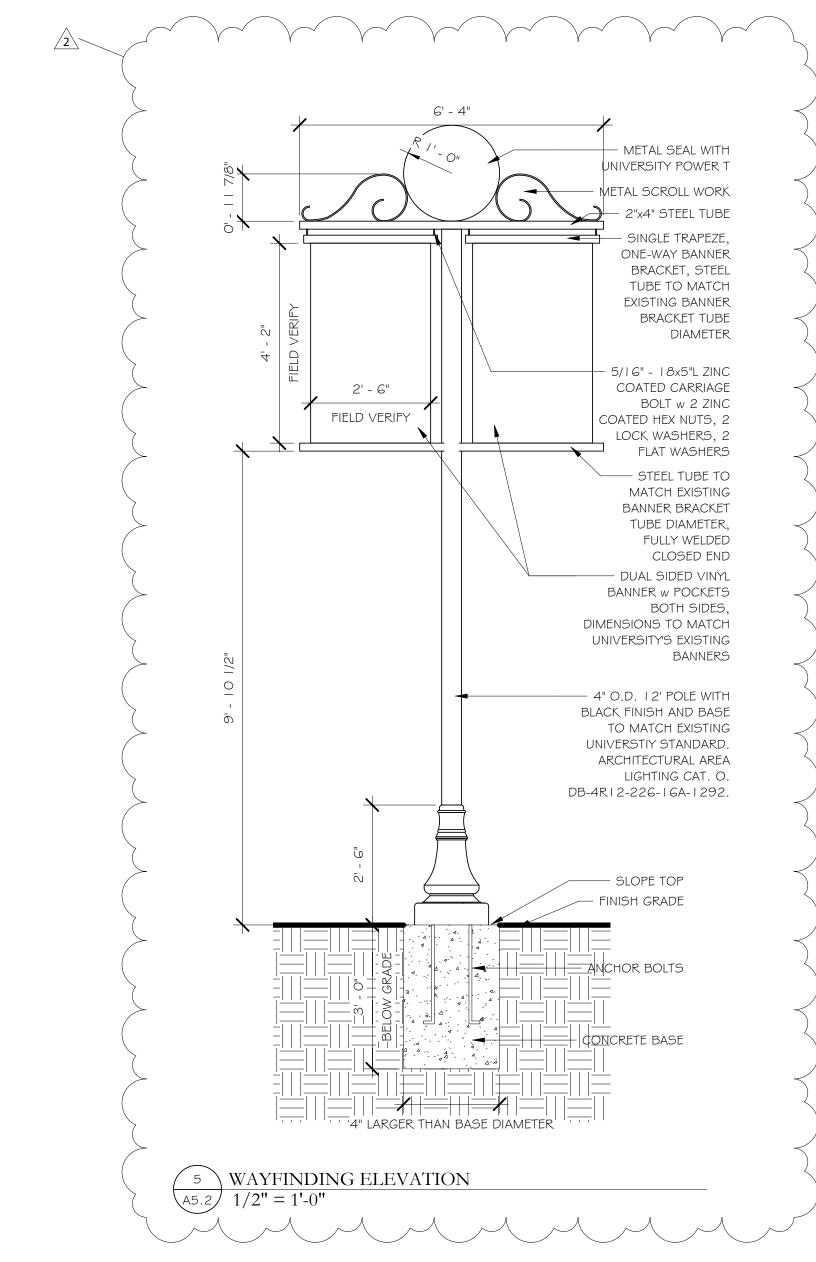
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Sheet Title SIGN ELEVATION

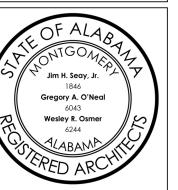

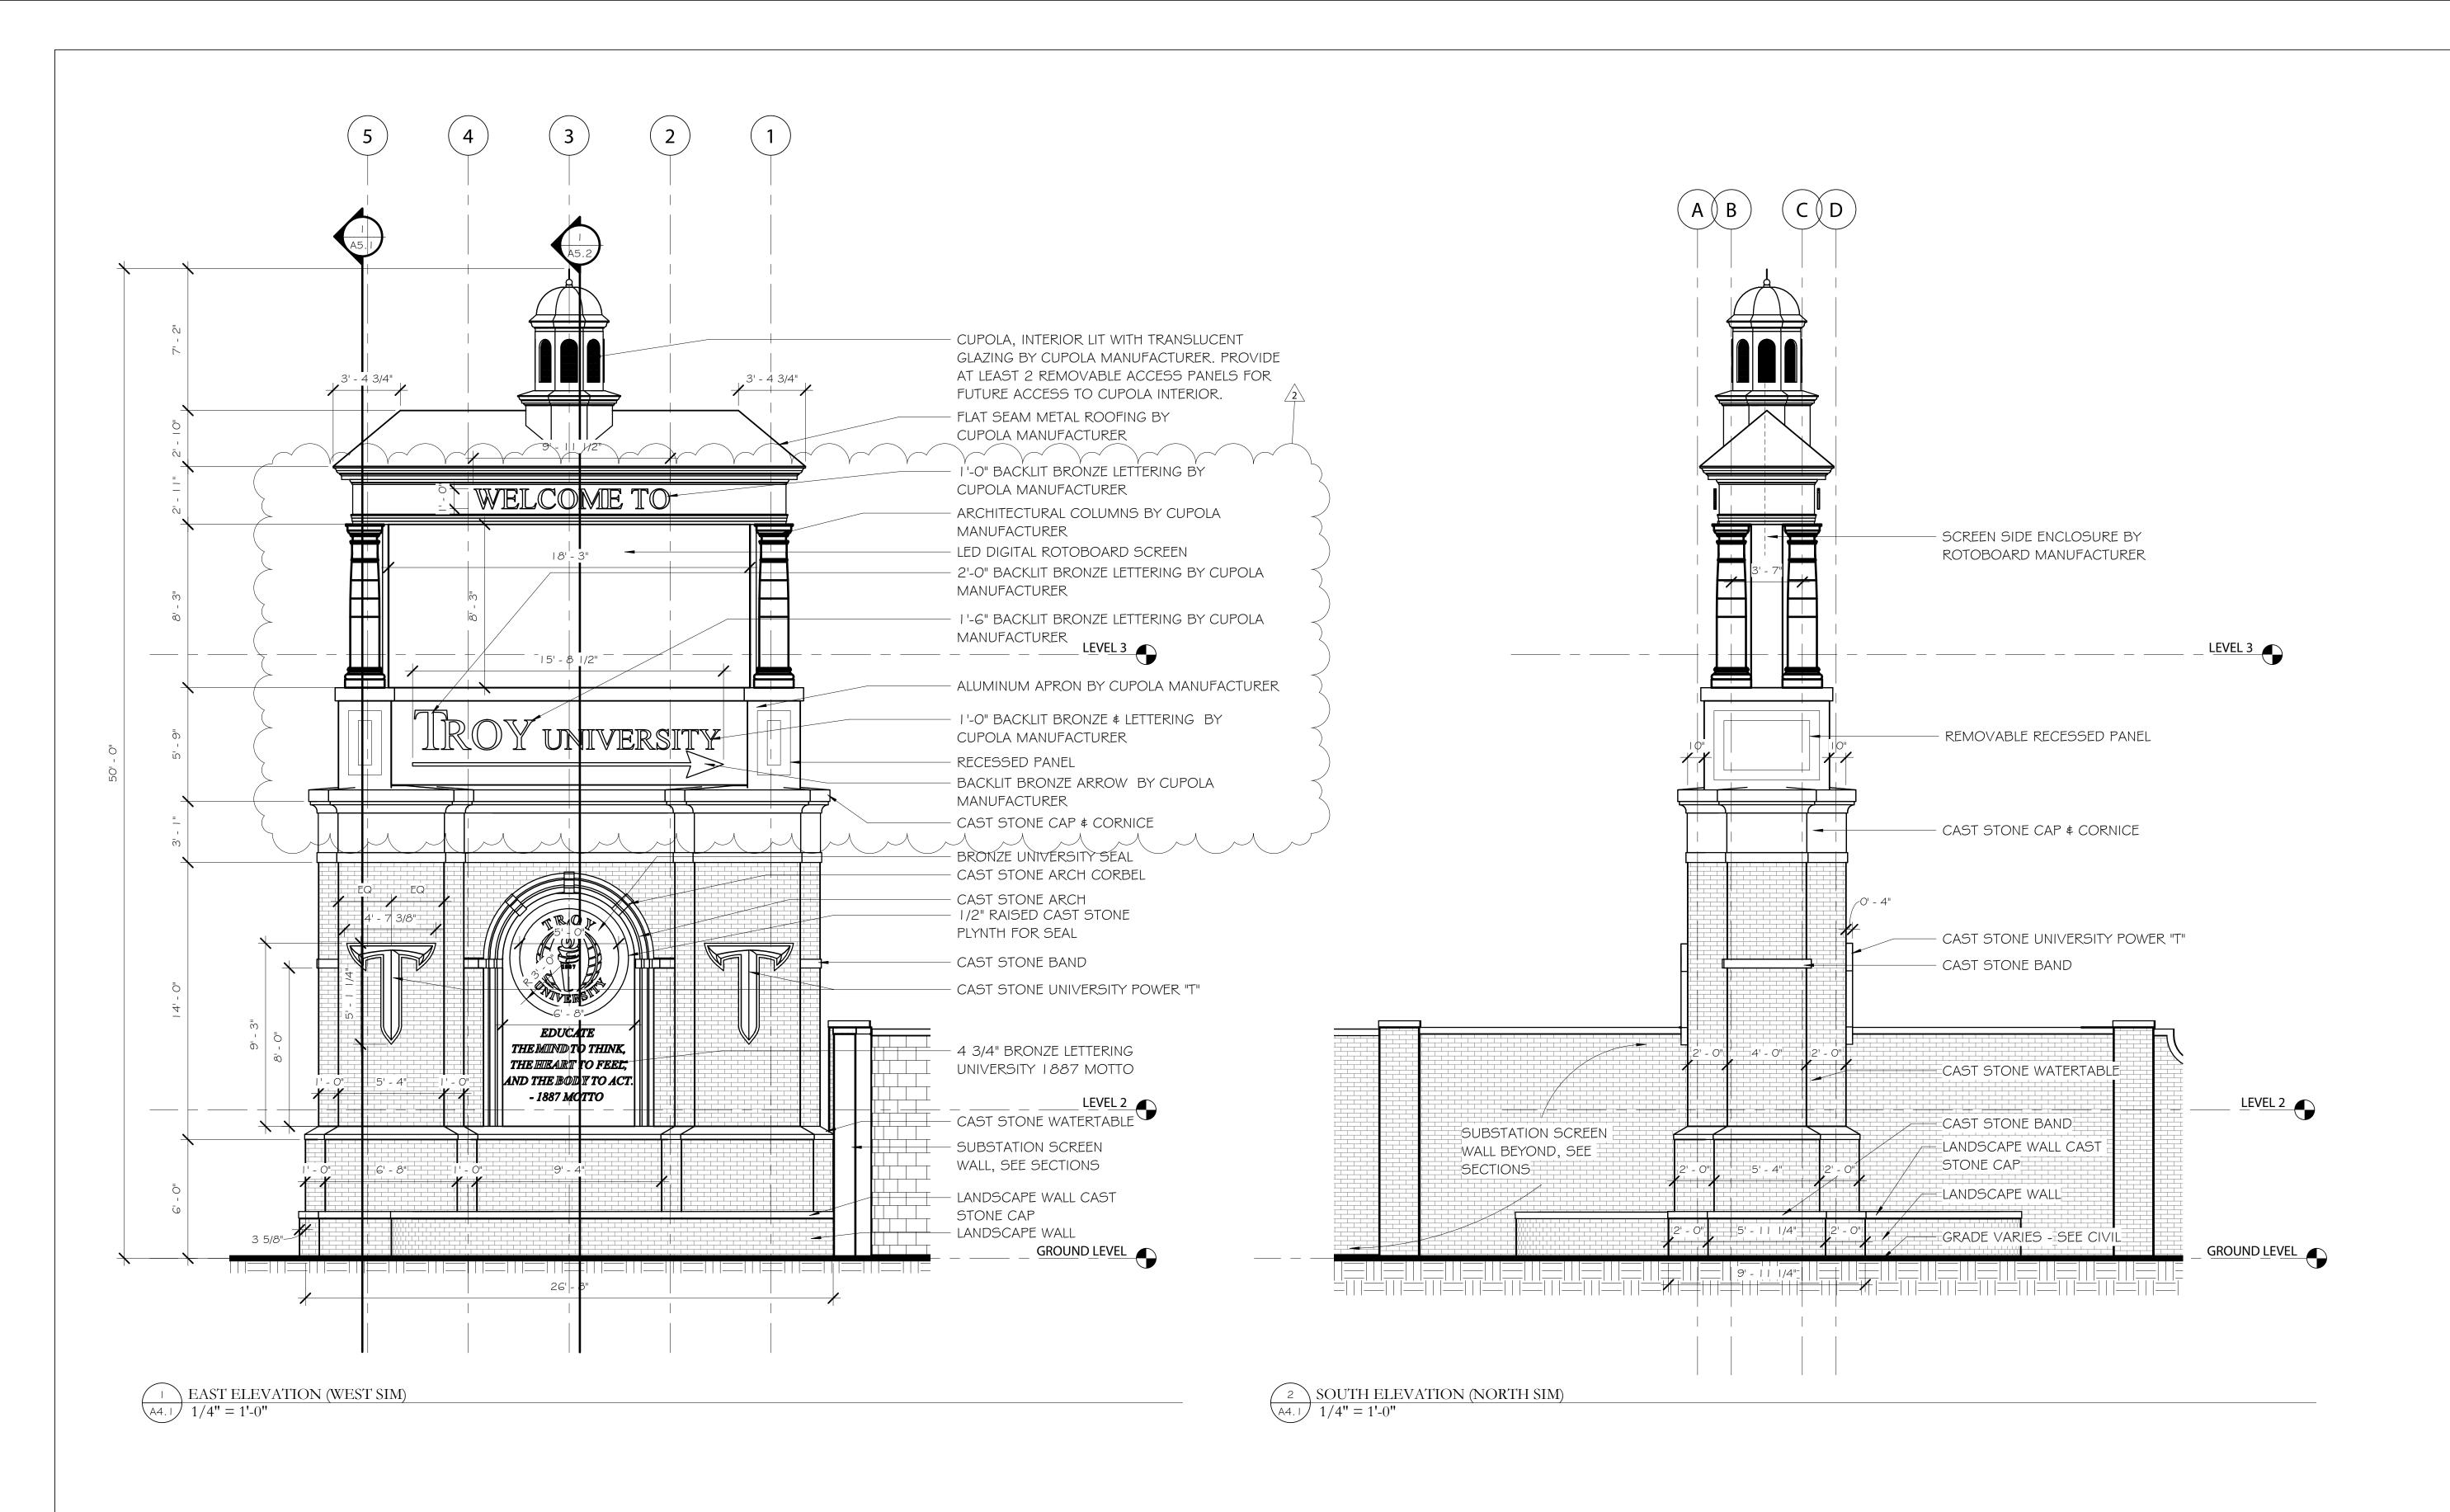





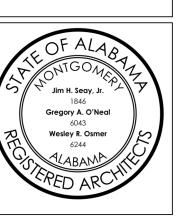

*RENDERING NOT FOR CONSTRUCTION USE.

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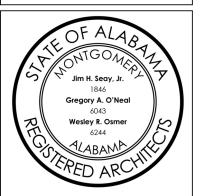
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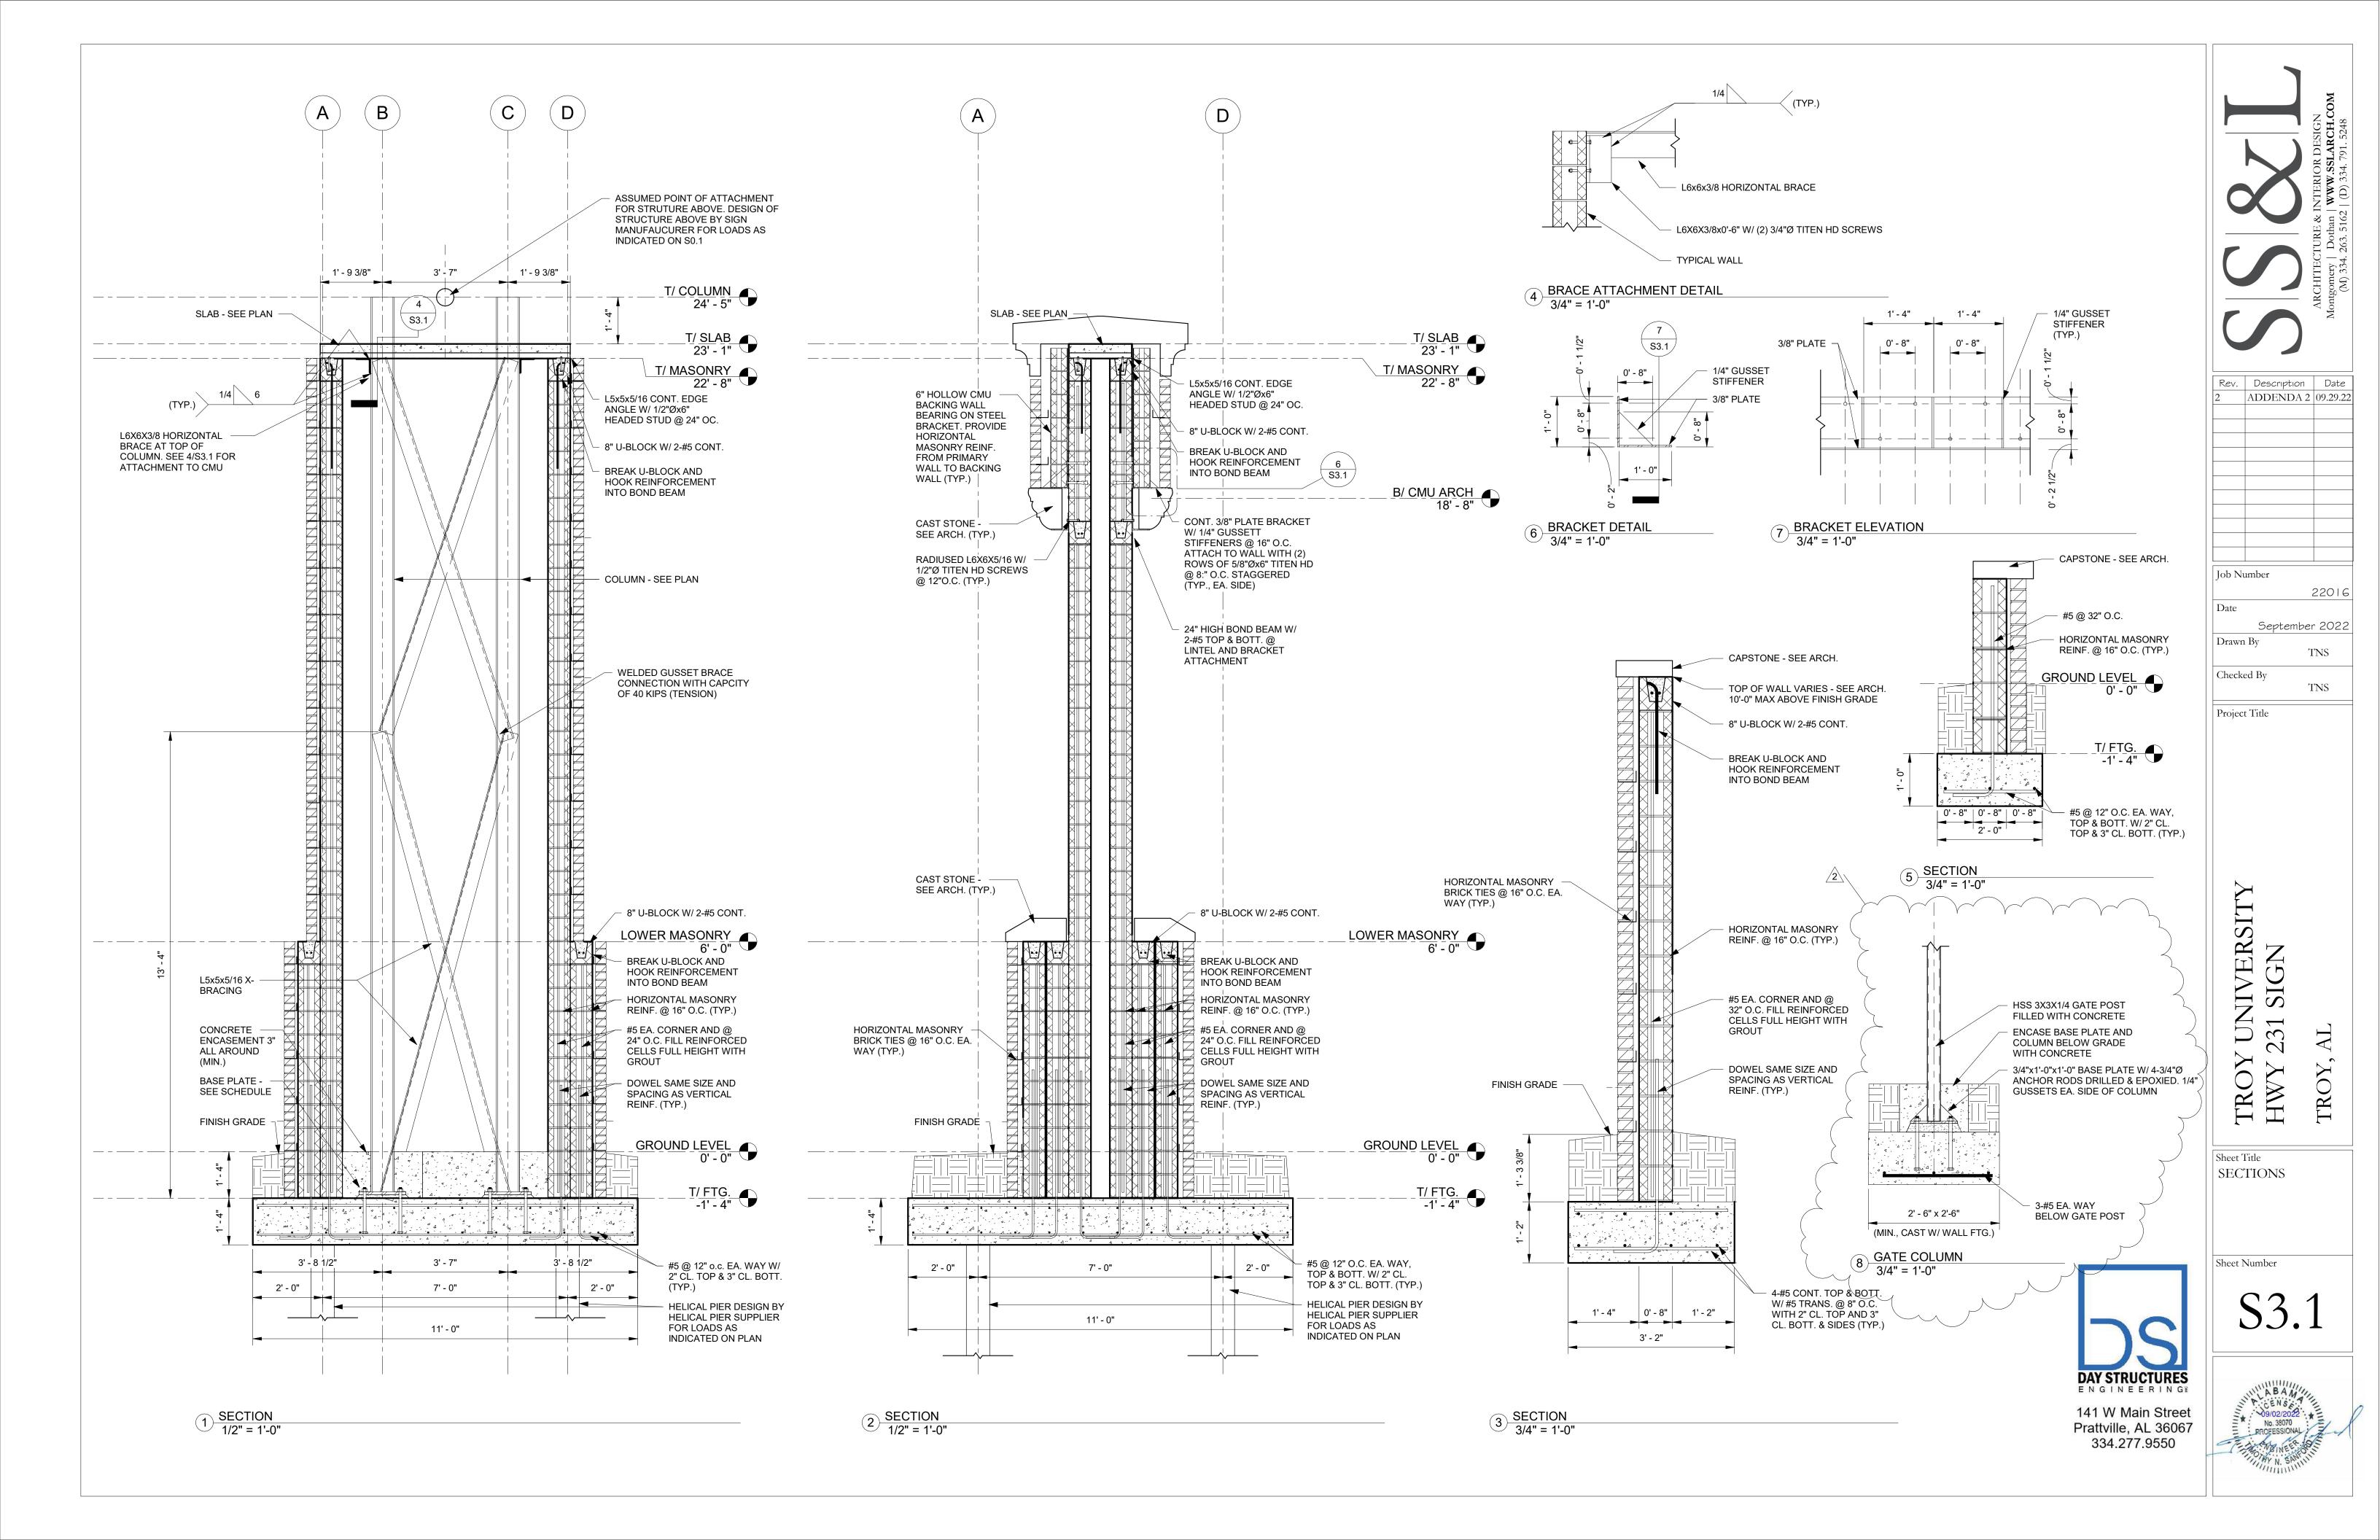
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SIGN SECTION AND DETAILS

Sheet Title





GENERAL ELECTRICAL NOTES

- PROVIDE GREEN INSULATED GROUND CONDUCTOR IN ALL RUNS IN ADDITION TO THOSE SHOWN.
 WHEN NO CONDUCTORS ARE SHOWN, THEN PROVIDE A PHASE, NEUTRAL AND GROUND
 CONDUCTOR.
- 2. AIM FLOODLIGHTS AT NIGHT TO EVENLY WASH WALL AND BRICK LOWER SECTION OF SIGN.
- 3. CONDUITS SHALL BE PVC OR RIGID GALVANIZED STEEL.
- 4. ALL PERSONNEL AND EQUIPMENT SHALL MAINTAIN AT LEAST 10' SEPARATION FROM ENERGIZED SUBSTATION POWER LINES AND EQUIPMENT. COORDINATE ALL WORK WITH UTILITY COMPANY.
- 5. PROGRAM BREAKER OPERATION TO OPERATE FLOODLIGHTS, BACK-LIT LETTERING AND LED DISPLAY AS DIRECTED BY OWNER. INSTRUCT OWNER HOW TO PROGRAM BREAKERS.


SIGN CONNECTION SCHEDULE								
NAME	PANEL	BREAKER	WIRE SIZE	NOTES				
BACK-LIT LETTERING (WEST SIDE)	LP	20A/1	2-#12 & 1-#12(GND) IN 3/4" C.	CONNECT TO LETTERING AS DIRECTED BY LETTERING INSTALLER. RUN OUT OF SITE AND UNDERGROUND.				
BACK-LIT LETTERING (EAST SIDE)	LP	20A/1	2-#12 & 1-#12(GND) IN 3/4" C.	CONNECT TO LETTERING AS DIRECTED BY LETTERING INSTALLER. RUN OUT OF SITE AND UNDERGROUND.				
LED DISPLAY (WEST SIDE)	LP	50A/2	3-#6 & 1-#10(GND) IN 1" C.	CONNECT TO LED DISPLAY AS DIRECTED BY LETTERING INSTALLER. COORDINATE BREAKER RATING AND WIRE SIZE WITH DISPLAY NAMEPLATE. RUN OUT OF SITE AND UNDERGROUND.				
LED DISPLAY (EAST SIDE)	LP	50A/2	3-#6 & 1-#10(GND) IN 1" C.	CONNECT TO LED DISPLAY AS DIRECTED BY LETTERING INSTALLER. COORDINATE BREAKER RATING AND WIRE SIZE WITH DISPLAY NAMEPLATE. RUN OUT OF SITE AND UNDERGROUND.				
CUPOLA LIGHT	LP	20A/1	2-#12 & 1-#12(GND) IN 3/4" C.	CONNECT TO CUPOLA LIGHT (BY OTHERS) AS DIRECTED BY CUPOLA INSTALLER. RUN OUT OF SITE AND UNDERGROUND.				


PANELBOARD SCHEDULE												
PANEL	TYPE	CABINET	MAINS			BRANCHES					REMARKS	
	O/IDINE!	TYPE	SIZE	PHASE FEED	REO'B	SPARE	FOTAL	POLES	FRAME	TRIP	KEMAKKS	
LP	SQ D	SURFACE	мсв	200A	1PH, 3W (1	2	3) 1	ECB-G3	20A	FLOOD LIGHTING
POWERLINK WITH U/L S.E. LABEL	NEMA 3R			120/240V W/GND BUS	2	0	2	1	ECB-G3	20A	BACK-LIT LETTERING	
			_		1	0	1) 1	ECB-G3	20A	CUPOLA LIGHT	
					2	0	2	1	EDB	20A	RECEPTACLE * IRRIGATION	
				9-:	9-29-22/2	2	0	2	2	EDB	**	LED DISPLAY
						6	0	6) 1	EDB	-	SPACE ONLY
** LED DISPLAY BREAKER SIZE TO BE COORDINATED WITH DISPLAY NAMEPLATE.												

PANELBOARD NOTES:

- 1. PROVIDE ARC-FLASH WARNING LABELS THAT COMPLY WITH NEC 110.16 ON ELECTRICAL EQUIPMENT.
- 2. PANEL SHALL HAVE NAMEPLATE ON OUTSIDE COVER STATING PANEL DESIGNATION, VOLTAGE AND PHASE AND WHERE SUPPLY OF
- POWER ORIGINATES PER NEC 408.4(B).
- 3. THE POWER DISTRIBUTION SYSTEM SHALL BE RATED FOR 10,000 A.I.C.

4. PANEL SHALL BE SQUARE D POWERLINK 1000 SERIES PANEL WITH CONTROLLABLE AND NON-CONTROLLABLE BREAKERS, TIMECLOCK AND PHOTOELECTRIC SWITCH OR APPROVED EQUAL. BREAKERS SERVING FLOOD LIGHTING AND BACK-LIT LETTERING SHALL BE CONTROLLED BY TIMECLOCK AND/OR PHOTOELECTRIC SWITCH.

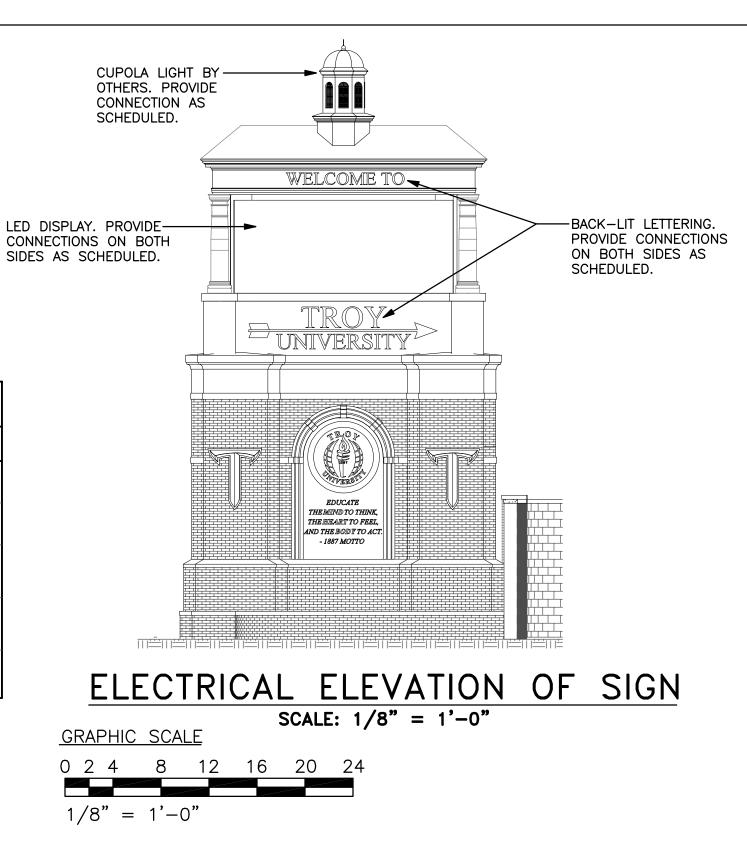

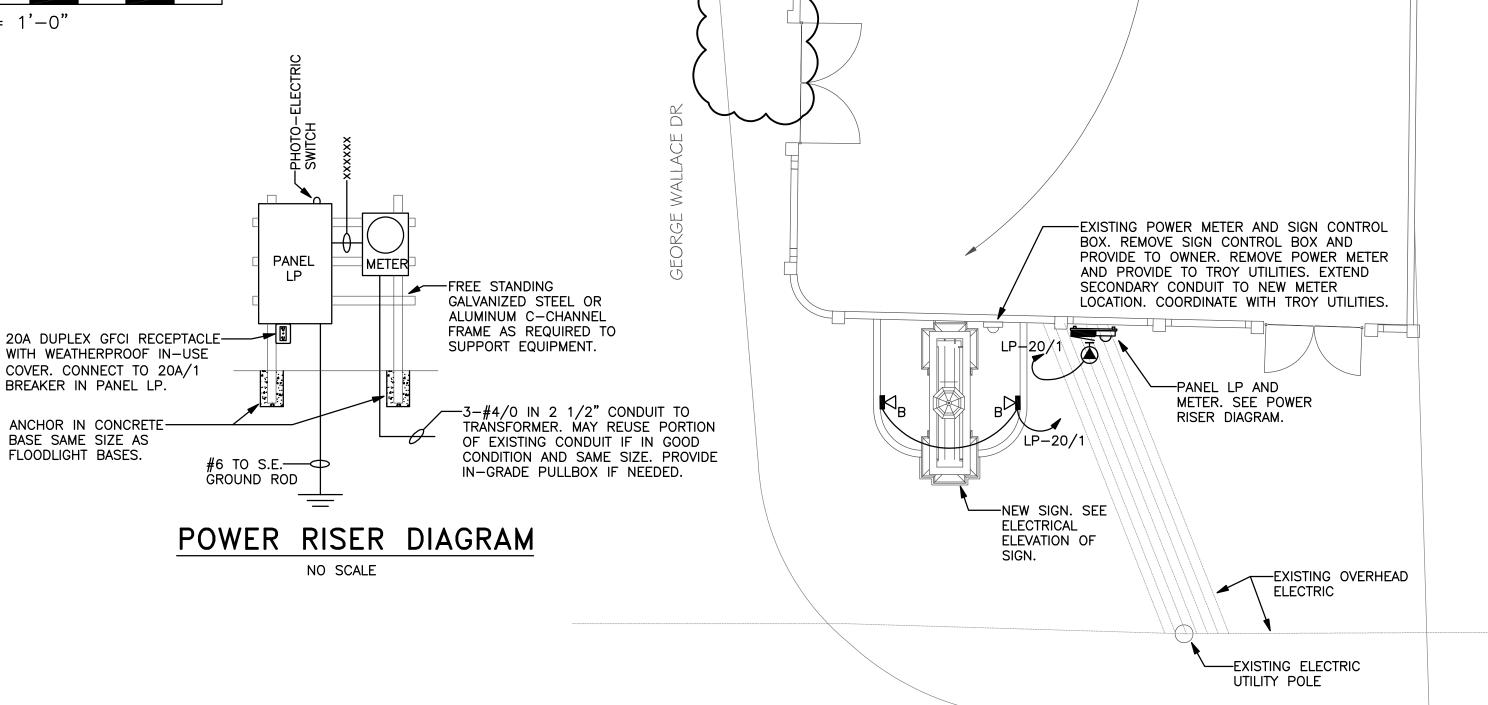


-EXISTING TRANSFORMER,

PRIOR TO BID.

VERIFY EXACT LOCATION

 $\sqrt{2}9-29-22$

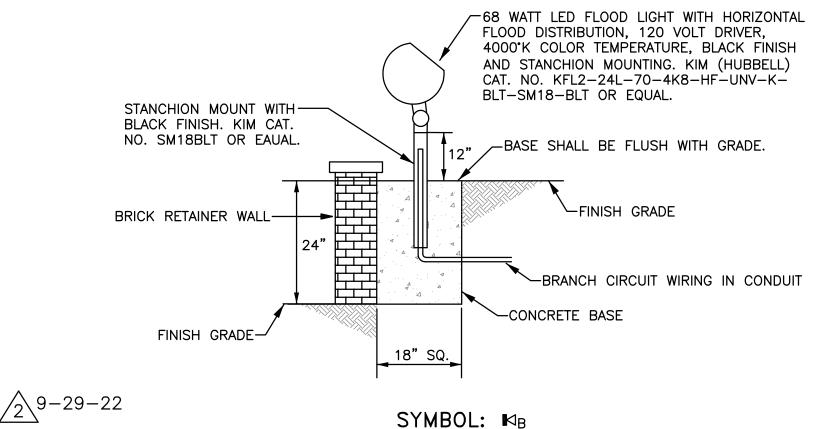

SIGN FLOODLIGHT DETAIL

NO SCALE

LEGEND:

- ✓ NEW LED FLOOD LIGHT, SEE DETAILS.
- BRANCH CIRCUIT WIRING IN UNDERGROUND PVC CONDUIT, 2-#10 & 1-#10(GND) CONDUCTORS IN 1" CONDUIT 24" BELOW GRADE UNLESS NOTED.
- IRRIGATION CONTROLLER CONNECTION, 120V. MAKE CONNECTION TO CONTROLLER AS DIRECTED BY IRRIGATION CONTRACTOR.



US HWY 23 I

SCALE: 1/16" = 1'-0"

ELECTRICAL SITE PLAN

POWERSOUTH SUBSTATION

MILLS-CONOLY
ENGINEERING, P.C.

8218 OLD FEDERAL ROAD MONTGOMERY, AL 36117
PHONE: (334) 270-0010 WEB: www.mills-conoly.com

0 4 8 16 24 32 40 48

1/16" = 1'-0"

ARCHITECTURE & INTERIOR DESIGN
Montgomery | Dothan | www.ssl.ARCH.COM
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2 Addenda 2 09.29.22

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22016

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Sheet Title

ELECTRICAL PLAN

Sheet Number

E1.0

